#### REQUEST FOR PROPOSAL

The Board of Education for Montague Area Public Schools will be receiving sealed bids for:

#### **RRO Elementary – Unit Ventilator Upgrades**

4859 Knudsen St. Montague, MI 49437

#### PROJECT INFORMATION

The purpose of this project is to upgrade the existing (6) unit ventilators. The details are addressed in the bid set located in pages 7-14 of this document.

All bids must be for the entire project. All major subcontractors shall be named by the bidder. The bidder shall specify its full name, address, contact person and telephone number, state whether it is a corporation, partnership, or individual, and include certificates evidencing current contractor's liability, commercial general liability, and vehicle liability insurance for the project amount specified in the bid documents.

Work shall commence after June 7, 2024 and be completed no later than August 2, 2024. The successful bidder shall work with Tom Cederquist, Director of Operations, regarding the project's schedule.

#### **BID PROPOSAL**

Sealed bids, in duplicate, will be received until **2:30 pm local time on Tuesday, May 7<sup>th</sup>, 2024** at the Montague Area Public Schools District Office, 4882 Stanton Blvd., Montague, MI 49437. Bids will be publicly opened and read aloud immediately after the closing of bids at the Central Office Conference Room located at the same address. Interested parties are invited to attend. Bids received after this time will neither be considered nor accepted.

All proposals shall be accompanied by a sworn and notarized Familial Disclosure Statement as well as Iran Economic Sanctions Act, both of which forms are included in the Bid Form.

All Bids may not be modified, withdrawn, or canceled for a period of sixty (60) days from the time and date of Bid receipt.

Proposals shall be in sealed opaque envelopes identifying the legal name and address of the submitting contractor's company, plainly labeled as follows:

Montague Area Public Schools
Sealed Bid Proposal – Unit Ventilator Upgrades
Attn: Jeff Johnson
4882 Stanton Blvd.
Montague, MI 49437

#### **BID SECURITY / PERFORMANCE BONDS**

Each bid shall be accompanied by a bid bond in an amount equal to five percent (5%) of the bid. Bid security shall be in the form of a Bid Bond, Cashier's Check, or Certified Check. This shall secure the Owner from loss or damage by reason of the withdrawal of the bid by a Bidder or by failure of the

successful Bidder to enter into a contract with the Owner if his bid is accepted by the Owner. Such checks shall be made payable to Montague Area Public Schools.

Once selected, the successful Bidder will be required to furnish performance and payment bonds in the amounts equal to 100% of the contract amount.

#### **PRE-BID SITE INQUIRIES**

Interested bidders are to contact Tom Cederquist, Director of Operations, with questions and requests to examine the construction site. Mr. Cederquist may be reached at 231-730-5228, Monday – Friday, 8:00 a.m. – 4:00 p.m.

#### **BID AWARD**

All bids received will be presented and considered by the Board of Education at 6:00 p.m. on Monday, May 13, 2024. The Board of Education reserves the right to waive irregularities and/or reject any and all bids, and also reserves the right to exercise the full discretion afforded to it by the law in the selection of the bidder and the awarding of the contract.

#### PREVAILING WAGES DO NOT APPLY TO THIS PROJECT



### **BID FORM**

#### **SUBMIT IN DUPLICATE**

BID TO:	_	ea Public Schools	
	•	Johnson, Superintendent	
	4882 Stanton		
	Montague, MI	49437	
BID FROM:			
	(Bidder Name)	)	
	(Address)		
	(City, State, Zi <sub>l</sub>	 ρ)	
PROJECT:	Montague Are	ea Public Schools, Unit Ventil	ator Upgrades, Project #5143
Ladies and Gent	lemen:		
the work and ha Engineering Cor all labor, materi	iving examined the s poration, 4801 Henral, taxes	I themselves with the local co ite and the Bidding Document y Street, Muskegon, MI 4944 , and services required for the thereto, for the sum of:	ts prepared by Rhoades 1 hereby propose to furnish
BASE BID AMOUI	NT:		Dollars ( \$ ),
	(use word	ds)	(use figures)
TAXES: Bid sum i	ncludes all applicable t	taxes, including Michigan Sales T	āx.
		t of furnishing a Performance Bo ne Base Bid for all bids exceeding	
Price of performa	nce, labor and materia	al bond (included in Base Bid)	. Dollars ( \$
ACKNOWLEDGEN	MENT OF ADDENDA:		
The following add the above Base B		ved, are hereby acknowledged, a	and their execution is included in
Addendum No	Dated	Addendum No	Dated

<b>VOLUNTARY ALTERNATES</b>	<u>:</u> :				
Identify in detail on appro	priate attachmei	nt any Vol	untary Alternates sho	wn here:	
1					
2					
3					
DID CECUDITY					
Accompanying this Bid, as (Certified Check / Cashier'	•			Security in the form of	
				Dollars ( \$	)
Payable to the Owner, wh the Owner, if the undersig incorporated in the Contradate of issuance of Letter CONSTRUCTION PROGRES	ned fails to exec act Documents a of Intent to Awa	ute the Co	ntract in conformity furnish specified bon	with the form of Contract	
If awarded the Contract, the	_	agrees to o	commence the Work	after June 7. 2024 and	
complete the Work in acco	_	-			
Endorses the Cons	struction Schedu	le:		r Initials)	
Amends the Const	ruction Schedule	e as follow	s:		
CONTRACTOR LABOR RAT	ES:				
In the event of a contract					
Contract amount, we will a rate plus all insurances, ta			•	•	_
and profit mark-up) for ea			THI BULLOTIS UTTU OTTICE	benefits before evernee	<b></b>
Job Title	Labor Rate		Job Title	Labor Rate	
	\$	/hr		\$	/hr

#### **CHANGE ORDER WORK:**

For revisions to the contract,	whether	deleted or	added,	the contractor	agrees to	the following	mark-ups
for overhead and profit:							

1.	Direct (own forces) Labor	 %
2.	Direct Material	 %
3.	Subcontracted Work	 %
4.	Equipment Rental	%

#### **CREDIT FOR WORK DELETED:**

Should any work be deleted from the Contract by order of the Owner, full cost savings realized thereby will be credited to the Owner.

#### **FAMILIAL DISCLOSURE:**

See Page 4 of this Bid Form for required Familial Disclosure Statement.

#### **IRAN ECONOMIC SANCTIONS ACT:**

See Page 5 of this Bid Form for required Iran Economic Sanctions Act.

#### **AGREEMENT:**

The undersigned agree(s) to provide the post-bid information required within ten (10) days after receipt of the Notice of Intent to Award and to execute an agreement for work covered by this Proposal on a Subcontract Agreement.

In submitting this bid, it is understood that the Owner reserves the right to reject any or all bids. It is further agreed that this bid is binding for a period of sixty (60) days from the opening thereof.

Respectfully submitted,	(If a Composition office and)
Date, 2024	(If a Corporation, affix seal)
Firm Name	
Address	
Ву	<del></del>
Signed	
Title	
Telephone No. ( )	
Email Address	

#### **FAMILIAL DISCLOSURE STATEMENT**

This form is required by State Law for the construction, addition, repair, or renovation of school buildings when that project cost exceeds the calculated threshold. For the 2023-24 year, that threshold is \$29,572 and it is adjusted annually by the Consumer Price Index. The law does not preclude bidders from submitting bids or a Board of Education from approving a bid with a familial relationship. The law requires the notification to allow Board members and the Superintendent to avoid recommending or voting on a conflict of interest.

"The legislation requires bidders to provide "a sworn and notarized statement disclosing any familial relationship that exists between the owner or any employee of the bidder and any member of the Board [of Education]...or Superintendent of the School District...A Board [of Education]...shall not accept [i.e. "approve"] a bid that does not include this sworn and notarized statement."

MCL 380.1267(3)(d)

The following are members of the Board for Montague Area Public Schools:

	Brent Raeth Tom Johnson	Cindy Francis Amanda Dahl		eishuizen Neubauer	Joel Smith	
The bidd	der must check one of t	he following:				
member	of the Montague Area	Public Schools Boar lationship between t	d.		e of the Bidder and any the Bidder and a member o	of
	Owner/Employee	Board M	<u>ember</u>		<u>Relationship</u>	
1.						
2.						
3.						
4.						
If addition	onal, please list on the	everse or another sl	neet.			
Sworn S	tatement: I swear that	I have prepared the	above informa	ation to the bes	t of my knowledge.	
 Signatur	re	Printed Name		Title	Da	_ te
Notary:	Subscribed an	d sworn this	day	Notary Pu	ıblic, State of	
	of		_ , 2024.		nission expires:	
	 Signature of N	 otary				

#### **IRAN ECONOMIC SANCTIONS ACT**

Michigan Public Act No. 517 of 2012

The undersigned, the owner or authorized officent	cer of	(the "Ridder")
pursuant to the compliance certification require (the "School District") Request for Proposals for certifies, represents and warrants that the Bide "Iran linked business" within the meaning of the 517 of 2012 (the "Act"), and that in the event the aforementioned RFP, the Bidder will not be course of performing the Work or any services	rement provided in the Montague Area I or the Unit Ventilator Upgrades (the "RFF der (including officers, directors and em ne Iran Economic Sanctions Act, Michiga Bidder is awarded a contract/purchase of ecome an "Iran linked business" at any t	Public Schools P"), hereby ployees) is not an n Public Act No. order as a result o
The Bidder further acknowledges that any pers responsible for a civil penalty of not more than contract/purchase order or proposed contract greater, the cost of the School District's investi fine. Moreover, any person who submitted a f proposal three (3) years from the date it is dete certification.	\$250,000.00 or 2 times the amount of to for which false certification was made, was gation, and reasonable attorney fees, in alse certification shall be ineligible to bid	the whichever is addition to the d on a request for
BIDDER:	NOTARY:	
	Subscribed and sworn this	day of
Name of Company		2024

Signature of Notary

Notary Public, State of \_\_\_\_\_

County of \_\_\_\_\_

My Commission expires:

Name and Title of Authorized Representative

Signature

Date

### UNIT VENTILATOR UPGRADES

## MONTAGUE AREA PUBLIC SCHOOLS

4859 KNUDSEN ST. MONTAGUE, MICHIGAN

PREPARED BY

# RHOADES ENGINEERING CORPORATION

TELEPHONE: 231-798-4328



NORTON SHORES, MICHIGAN

49441

REC FILE No. 5143A

SHEET INDEX

SECOND FLOOR ELECTRICAL DEMOLITION PLAN FIRST AND SECOND FLOOR ELECTRICAL PLAN

SHEET E - 3: ELECTRICAL SPECIFICATIONS

SECOND FLOOR MECHANICAL DEMOLITION PLANS SHEET MD-1:

SECOND FLOOR MECHANICAL PLANS SHEET SHEET MECHANICAL SCHEDULES AND DETAILS M-2:

This drawing is an instrument of service and shall remain the property of Rhoades Engineering Corporation whether or not the project for which it is intended is constructed This drawing and the concepts and ideas contained herein shall not be used, reproduced, revised, or retained without the express written approval of Rhoades Engineering Corporation.

Submission or distribution of this drawing to meet official regulatory requirements or for other purposes in connection with the project is not to be construed as publication in derogation of any of the rights of Rhoades

Verify existing conditions. Any discrepancies, noncompliance, or unclear items shall be reported to Rhoades Engineering Corporation, in writing, and shall be resolved before the commencement of work.

Any abridgment or violation of the rights of Rhoades Engineering Corporation shall be prosecuted to the fullest

Do Not Scale Drawings!

Engineering Corporation.

extent of the law.

MONTAGUE
RENOVATION T SEAL & SIGNATURE ISSUED FOR:

JE AREA PUBLIC SC N TO R.R. OEHRLI ELEME N ST. MONTAGUE, MI

/22/24 PERMITS, BIDS 8 CONSTRUCTIO

PROJECT No. 5143 DRAWING TITLE:

COVER PAGE

SHEET No.



E.C. SHALL DISCONNECT EXISTING CIRCUIT SERVING UNIT VENTILATOR BEING REMOVED. E.C SHALL REMOVE CONDUIT AND WIRE BACK TO THE SOURCE.

GENERAL DEMOLITION NOTES

 E.C. SHALL VERIFY ALL CIRCUITING PRIOR TO STARTING DEMOLITION.
 E.C. SHALL REMOVE ALL CONDUIT AND WIRE BACK TO THE SOURCE, EXCEPT AS NOTED TO BE RE-USED FOR NEW LOADS.

3. E.C. SHALL DISCONNECT, REMOVE AND DISPOSE OF ALL ELECTRICAL

— EXISTING PANEL "LP-2A" A210

SECOND FLOOR ELECTRICAL DEMOLITION PLAN

SCALE: 1/8" = 1'-0"

This drawing is an instrument of service and shall remain the property of Rhoades Engineering Corporation whether or not the project for which it is intended is constructed This drawing and the concepts and ideas contained herein shall not be used, reproduced, revised, or retained without the express written approval of Rhoades Engineering Corporation.

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DATE: ISSUED FOR: 4/22/24 PERMITS, BIDS &

CONSTRUCTION

SEAL & SIGNATURE


MONTAGUE AREA PUBLIC SC RENOVATION TO R.R. OEHRLI ELEMEI 4859 KNUDSEN ST. MONTAGUE, MI

PROJECT No. 5143

DRAWING TITLE:
SECOND FLOOR
ELECTRICAL
DEMOLITION PLAN

SHEET No.

**L**-

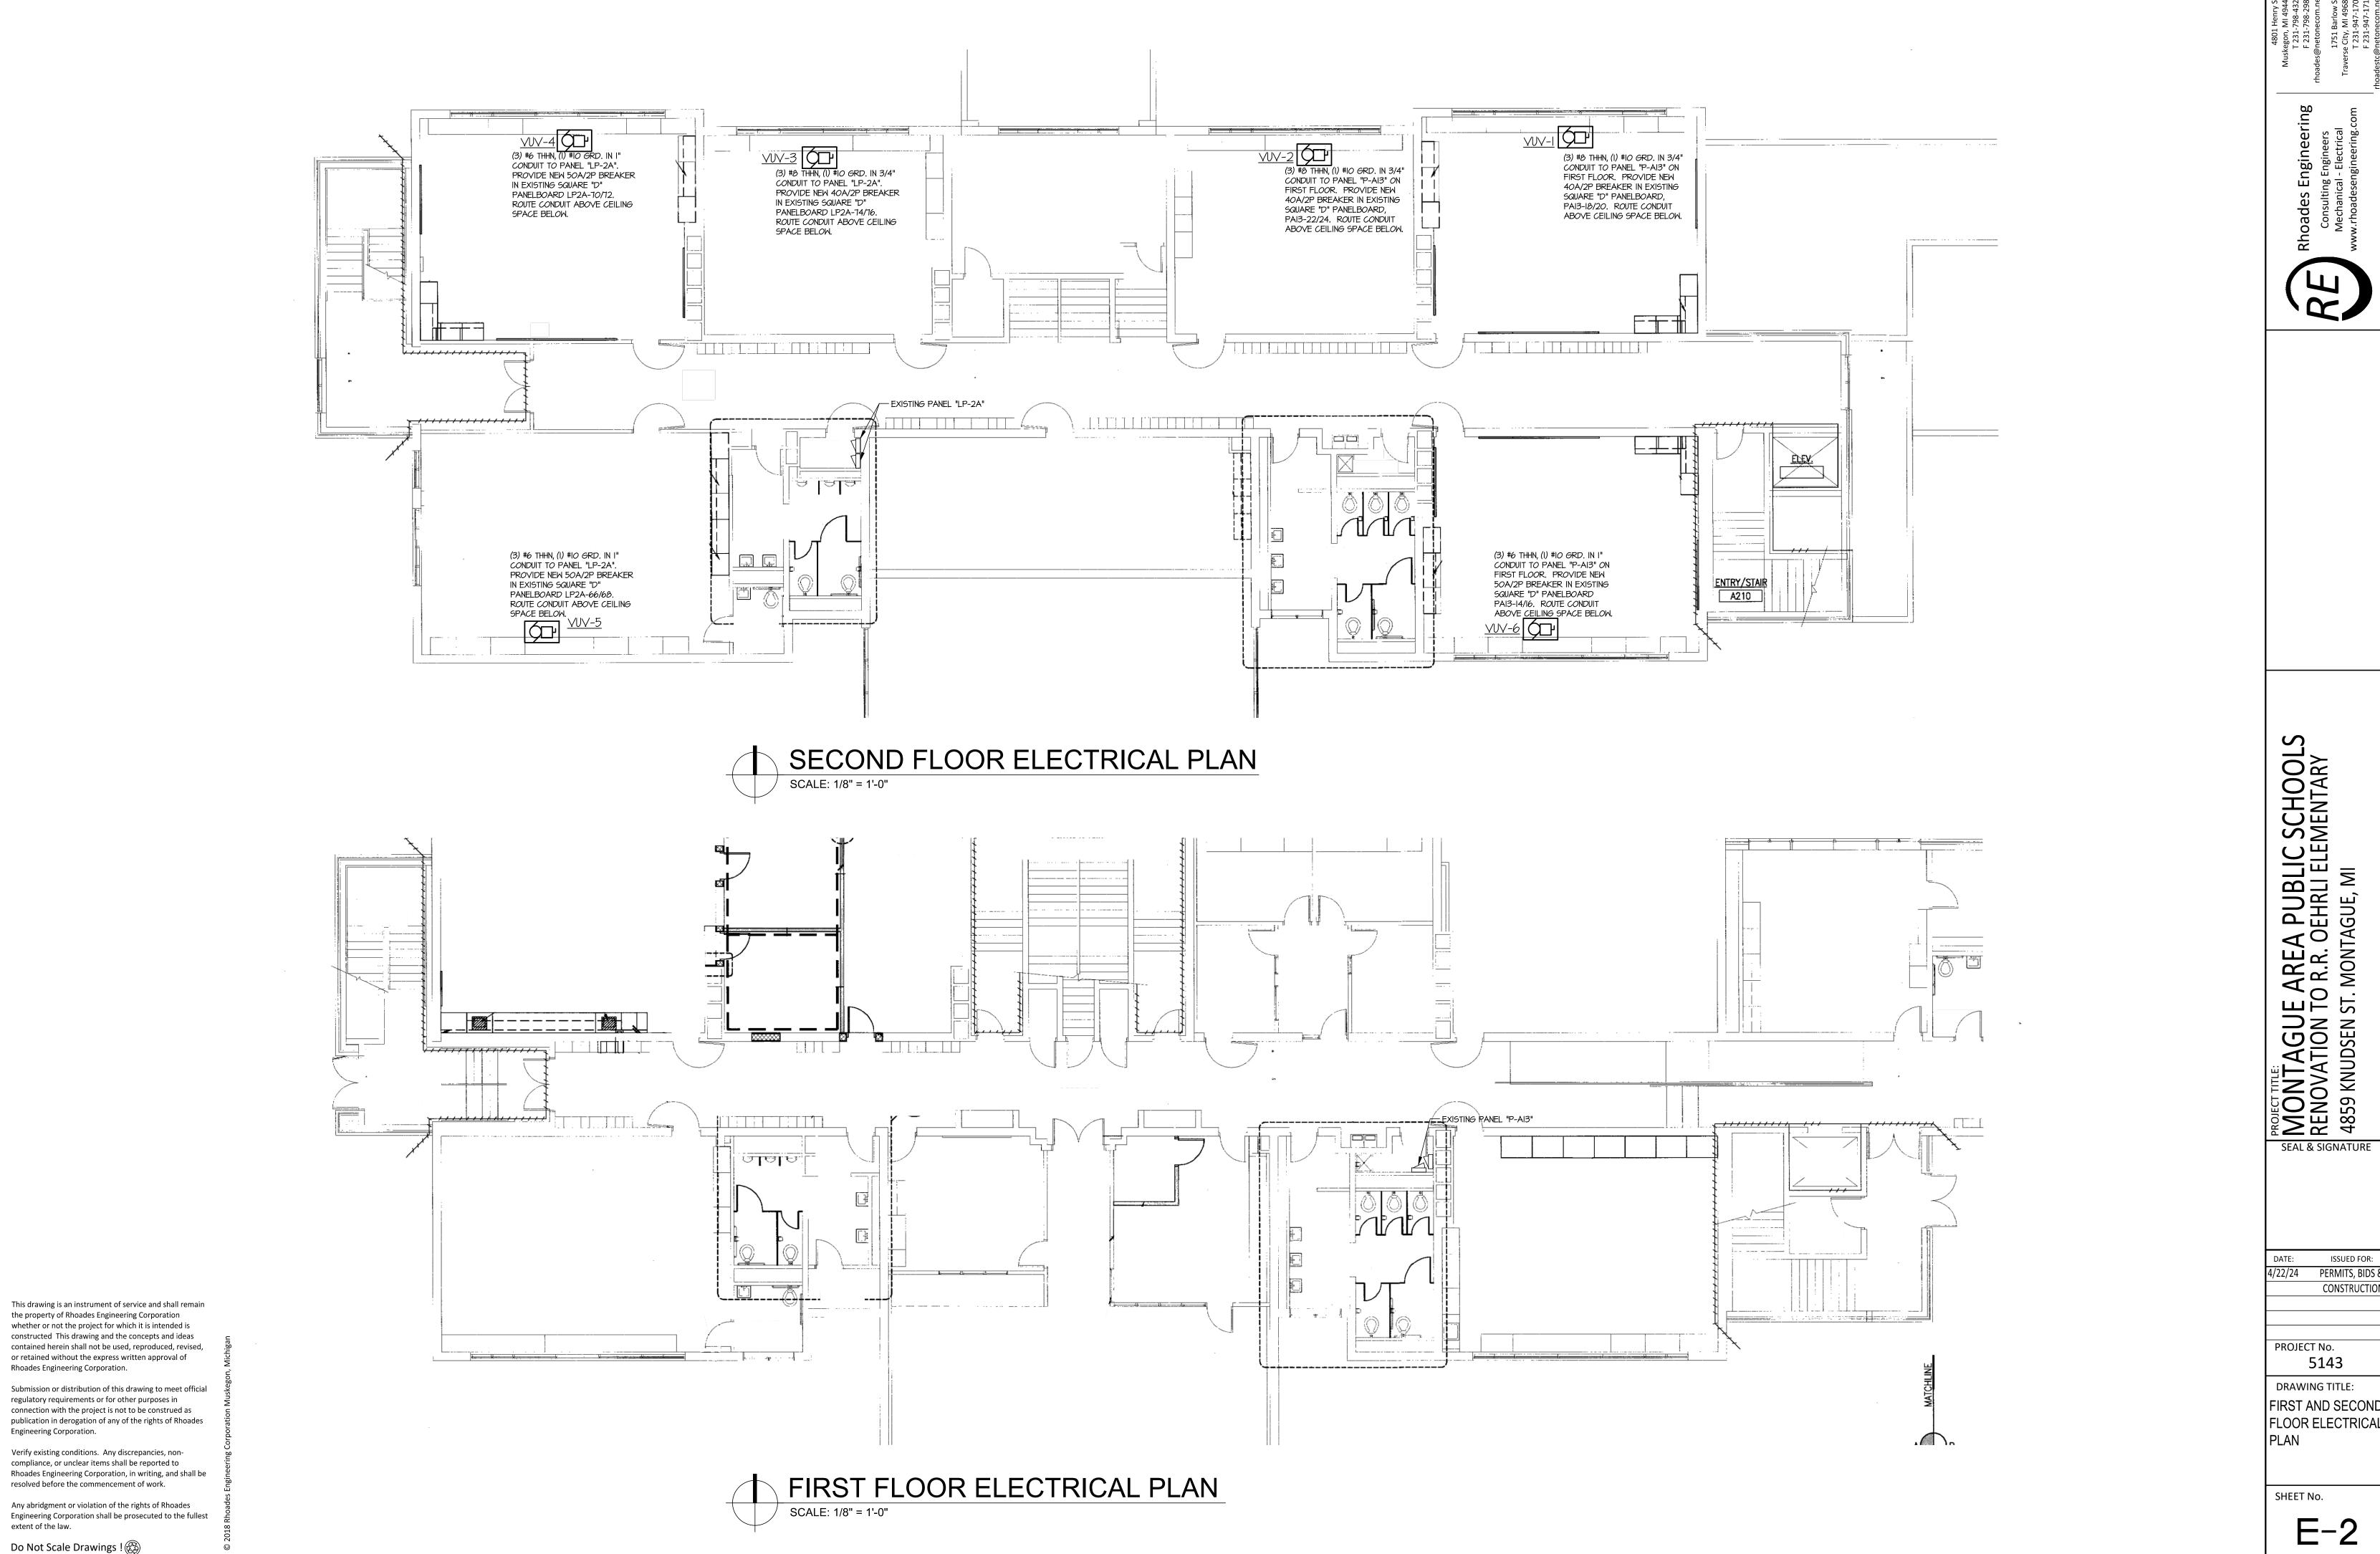

Rhoades Engineering
Consulting Engineers
Mechanical - Electrical



MONTAGUE AREA PUBLIC SC MONTAGUE AREA PUBLIC SC RENOVATION TO R.R. OEHRLI ELEMEI 4859 KNUDSEN ST. MONTAGUE, MI SEAL & SIGNATURE

ISSUED FOR:

CONSTRUCTION

PROJECT No. 5143

DRAWING TITLE: FIRST AND SECOND FLOOR ELECTRICAL

contained herein shall not be used, reproduced, revised,

Verify existing conditions. Any discrepancies, noncompliance, or unclear items shall be reported to Rhoades Engineering Corporation, in writing, and shall be resolved before the commencement of work.

Any abridgment or violation of the rights of Rhoades Engineering Corporation shall be prosecuted to the fullest extent of the law.

Do Not Scale Drawings!

Engineering Corporation.

DIVISION 16 - ELECTRICAL

SECTION 16000 - GENERAL ELECTRICAL REQUIREMENTS

PART I - GENERAL

I.I Related Documents

Drawings and general provisions of Contract, including General and Supplemental Conditions and Division I Specifications sections, apply to the work of all Division 16 Sections.

1.2 General

A. The work in this division consists of furnishing all labor and materials, accessories, equipment, transportation, supervision, startup services, instructions, permits and incidentals, and related items necessary to complete installation and successfully test, startup and operate, in a practical and efficient manor, all electrical work and systems indicated on the drawings and described in each Section of this Division.

B. The work shall also include any items which, while not specifically included in these specifications or drawings, are reasonable and properly inferable therefrom or are accepted trade practice or necessary for the proper completion of this System.

C. All materials used shall be new, in good condition and shall bear the U.L. label or listing.

D. Electrical Drawings and Specifications are intended to supplement each other and all work specified or indicated in either shall be provided. Should the drawings disagree in themselves or with the specifications, the better quality or greater quantity shall be provided.

1.3 Codes, ordinances, permits, fees or assessments

A. All work and materials shall be installed in accordance with the standards as described by all applicable federal, state and local codes and ordinances including the Michigan Electric Code, the Michigan Building Code, MIOSHA and ADA. The Electrical Trades shall be responsible for obtaining all necessary permits and inspections and shall include the cost of all such in his proposal. After completion of the work, the Electrical Trades shall furnish to the Owner a certificate of final inspection and approval from the Inspection Bureau having jurisdiction.

1.4 Warranty

A. All labor, materials and equipment shall be quaranteed by the Contractor and/or warranted by the manufacturer for one (1) calendar year after date of final acceptance, except where specific, longer periods are specified. Make all necessary alterations, repairs, adjustments and replacements during guarantee period as directed by Engineer to comply with drawings and specifications. Such work shall be at no cost to the owner.

1.5 Operating and Maintenance Instructions

A. Refer to division I.

B. Before Owner acceptance of the work, provide detailed verbal instructions, for a period of two (1) day at four (4) hours per day, to the Owner's operating personnel regarding the installed

C. Furnish to the Owner (3) sets of neatly bound and indexed operating and maintenance manuals for electrical work consisting of the following:

1. Complete instruction manuals, including a description of operation for each piece of equipment 2. Complete maintenance information.

3. Wiring diagrams.

6. Manufacturer's literature on all equipment and systems.

7. Shop drawings for each piece of equipment.

8. As-built drawings (two sets). 9. Warranties

1.6 Record Drawings

A. Refer to Division I Specifications

SECTION 16010 - BASIC ELECTRICAL MATERIALS AND METHODS

PART I - GENERAL

I.I Quality Assurance

A. All Work shall be performed by persons who are experienced in the appropriate Trade. B. Materials shall be new, of first-class quality and shall be furnished complete including delivery, erection, finish and connections.

C. Where a product is not named to establish quality or kind, the Contractor shall obtain approval of the Engineer prior to use of a product.

D. Where products are named by make and model number, these products are the basis of the System design. Where products by other approved manufacturers are used, the contractor shall include in his bid all additional work required for installation of that product, including work of other trades. Contractor shall also be responsible for verifying that equipment will fit into space provided and shall pay all additional costs associated with all such equipment that will not fit into the space provided.

E. When two or more items of the same equipment are required (lighting fixtures, wiring devices, panel-boards, transformers, etc.) they shall be of the same manufacturer.

F. Provide products which are compatible within systems and with other connected items.

6. All Work shall be coordinated and Scheduled with the Owners Representative / Project Manager H. Coordination with Mechanical Work: Coordinate motor control wiring with Division 15 Contractor. Refer to Division 15. The following division of work between the Mechanical Contractor's Temperature Controls Installer and the Electrical Contractor:

PART 2 - PRODUCTS

2.I WIRING MATERIALS

A. Feeders: Stranded copper conductor, 600 Volt insulation, rated a minimum 90° C, Minimum Size #12 AWG, Type THHN or XHHW in minimum 3/4" EMT type conduit unless otherwise approved.

B. Branch Circuits for lighting, receptacles and power loads with Minimum Circuit Ampacity of 20 Amperes or less: Homé runs shall be stranded copper conductor, rated a minimum 90° C, Minimum Size #12 AMG, Tupe THHN or THMN in minimum 3/4" EMT type conduit unless otherwise approved. Type "AC" cable may be used for whips.

C. Use color coded conductors as follows:

208Y/I20V Phases: Black, Red and Blue Neutral: White Ground: Green

2.2 ELECTRICAL SUPPORTING MEANS

A. Use galvanized steel or nonmetallic supports in wet and damp locations.

B. Strength of supports: Adequate to carry all present and known future loads times a safety factor

PART 3 - EXECUTION

3.1 General

A. All equipment installations shall be according to the product manufacturer's written installation

B. Coordinate Electrical equipment and materials installations with all new and existing building components. Route all conduits in spaces indicated and as job conditions warrant; arranged for most convenient servicing access and with due consideration given to other installers' work. If final locations of Electrical Equipment vary from those shown on the plans, Electrical Installer shall coordinate with all affected trades at no added cost to the owner.

C. Arrange for chases, slots and openings in other building components to allow for electrical installations.

D. Phase and schedule in accordance with the construction phases as indicated in Division I.

E. Rough-in: Verify final locations for rough-ins by field measurements. Refer to construction documents and equipment submittals for rough-in requirements.

F. Coordinate the installation of required supporting devices and sleeves to be set in poured in place concrete and other structural components as they are constructed.

6. Sequence, coordinate and integrate the installations of Electrical materials and equipment for efficient flow of Work. Give particular attention to large equipment requiring positioning prior to closing-in the building.

H. Where mounting heights are not detailed or dimensioned, install electrical services and overhead equipment to provide the maximum headroom possible.

I. Install electrical equipment to facilitate maintenance and repair or replacement of equipment components. As much as practical, connect equipment for ease of disconnecting, with minimum of interference with other installations.

J. Coordinate connection of mechanical systems with exterior utilities and services. Comply with requirements of governing regulations, franchised service companies and controlling agencies. Provide required connection for each service.

K. Install items level, plumb and parallel to other building systems and components except where otherwise indicated.

L. Give right of way to raceways and piping systems installed at a required slope.

3.4 Delivery, Storage and Handling

A. Deliver products to project properly identified with names, model numbers, types, grades, compliance labels and similar information needed for distinct identification; adequately packaged and protected to prevent damage during shipment, storage and handling.

B. Store equipment and materials at the site, unless off-site storage is authorized in writing. Protect stored equipment and materials from damage.

C. Coordinate deliveries of electrical materials and equipment to minimize construction site conqestion. Limit each shipment of materials and equipment to the items and quantities needed for the smooth and efficient flow of installations.

3.5 Protection

A. Protect all fixtures, equipment and materials at all times, whether new or existing to remain. B. Make good all damages caused, whether directly or indirectly, by Electrical Installer's personnel. . Close all pipe openings with caps and plugs during installation. D. Tightly cover and protect all fixtures and equipment against dirt, water, chemical and mechanical

injury.

E. Deliver all work in a thoroughly clean, perfect, unblemished condition at completion. F. Protect new and existing footings from undermining created by excavations.

3.6 WIRING INSTALLATION REQUIREMENTS

A. Receptacle and lighting circuits shall be installed in separate raceways

B. Wiring at outlets: install at least 6" of slack conductor at each outlet.

C. Wiring at lighting fixtures: Provide adequate (maximum 10'-0") flexible conduit to allow lighting fixtures to be relocated one ceiling grid tile dimension in any direction. Hospital grade AC cable may

D. At least one ground wire sized per the National Electric Code shall be installed in each branch

E. All circuit conductors must be tailed at devices so that circuit integrity is not dependent on device

F. Junction boxes located above ceilings shall be 4" square x 2 1/8" deep with 1/2" \$ 3/4" knockouts.

3.7 IDENTIFICATION

A. Panelboard numbers shall comply with the owners standard numbering system.

B. Each panelboard, motor starter, disconnect switch, etc. shall be identified with an engraved nameplate. Nameplates shall be 1", 5-ply lamacoid with 1/2" high white letters. Black background shall be used for panelboards, etc. supplied by the Normal Power System and Red background shall be used for panelboards, etc. supplied by the Emergency Power System. "Dymo" or tape markers will not be

C. Each panelboard shall be equipped with a typewritten circuit schedule indicating rooms and / or

D. Each junction box cover shall be labeled with panel and circuit numbers.

E. Each outlet and switch cover shall be labeled with panel and circuit number. Labels shall be tape type with clear background and black lettering.

F. Provide permanent operational dated nameplate on each item of power operated mechanical equipment, indicating manufacturer, product name, model number, serial number, capacity, operating and power characteristics, labels of tested compliances, and similar essential data. Affix nameplates in accessible locations.

A. Fire stop all penetrations of rated walls and floors with U.L. listed material. Each fire stopping material shall be installed according to it's U.L. listing.

3.9 Access Doors

A. Furnish for installation by general contractor wall and ceiling access doors for each junction box or

C. Wall and ceiling access doors shall be Larsen, Milcor or Karp of style and rating to fit construction.

SECTION 16476 - DISCONNECT SWITCHES, CIRCUIT BREAKERS AND MOTOR STARTERS

wiring device where these items are located above ceilings (except lay-in) or behind walls.

PART I - PRODUCTS I.I MANUFACTURERS

A. Square D B. Other Approved

1.2 DISCONNECT SWITCHES

A. Heavy-Duty (HD), Rated 240 Volt or 600 Volt as required. B. Fused or non-fused as indicated on drawings

C. Enclosure: NEMA I for indoor use and NEMA 3R for outdoor use.

SEAL & SIGNATURE

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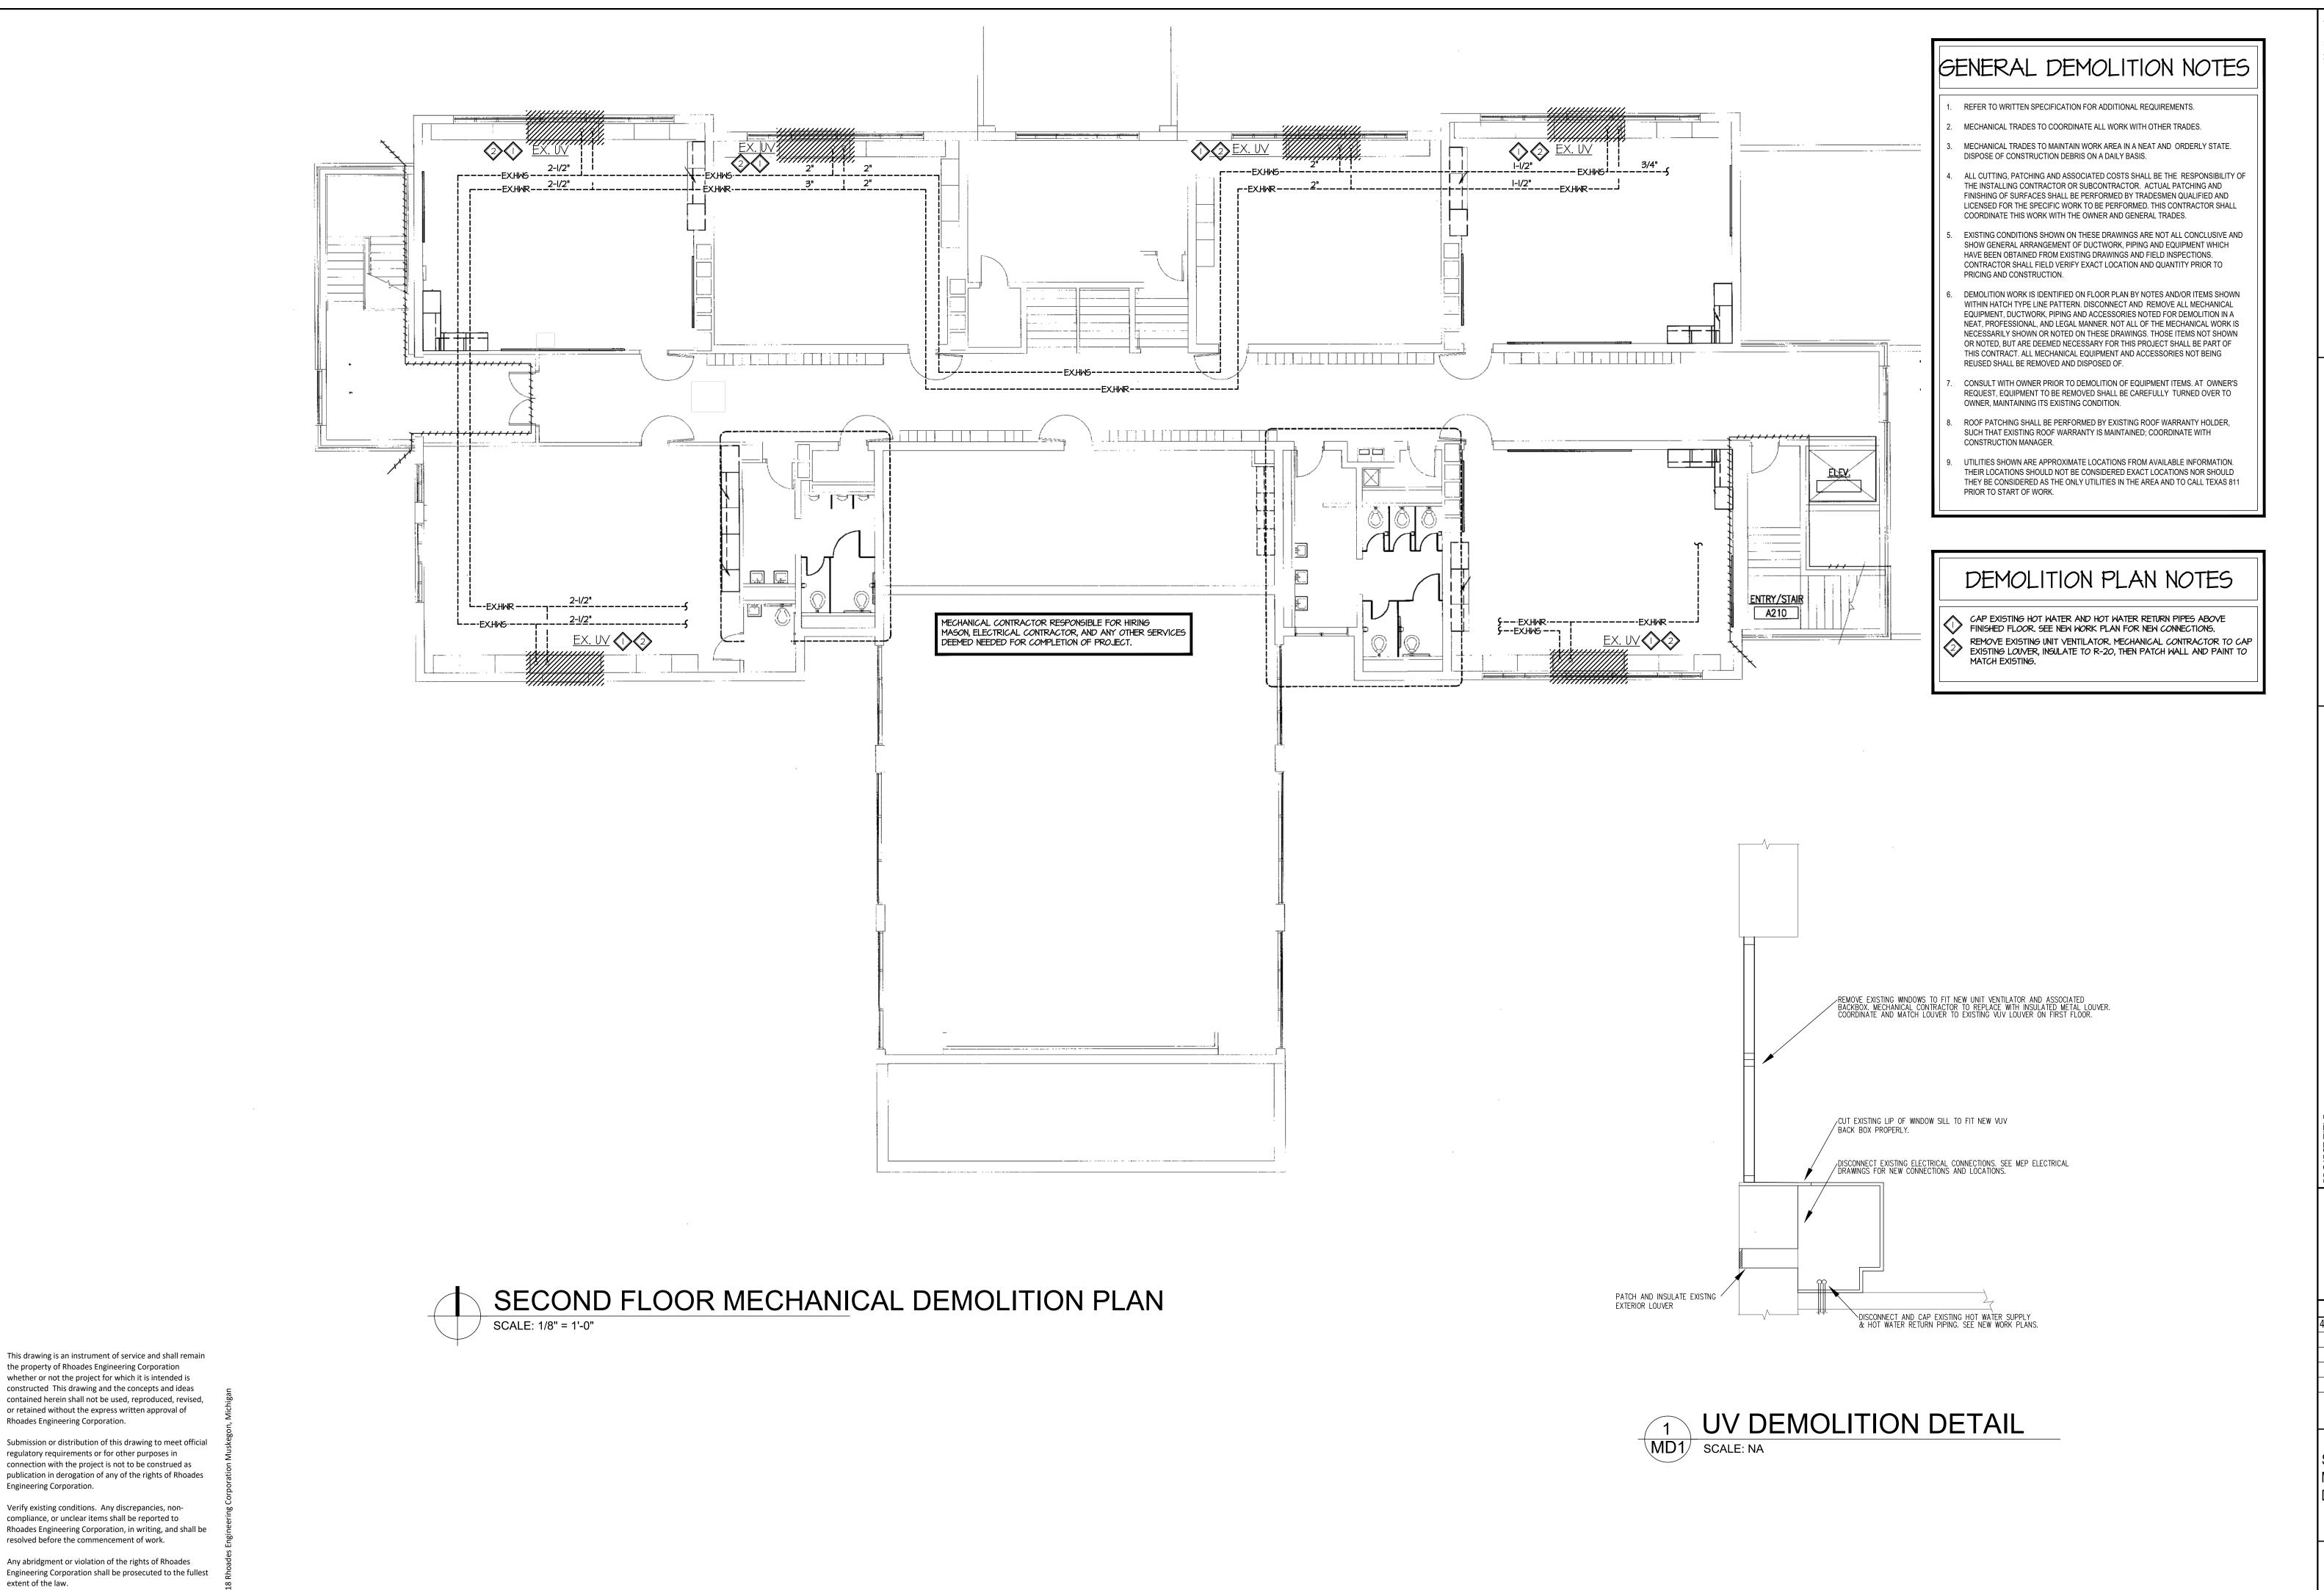
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ISSUED FOR: 4/22/24 PERMITS, BIDS 8 CONSTRUCTIO

PROJECT No. 5143

DRAWING TITLE: **SPECIFICATIONS** 

SHEET No.



Do Not Scale Drawings!

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s thoades@neton
al Traverse City,
g.com F 231

Shoades Engineerin
Consulting Engineers
Mechanical - Electrical



MONTAGUE AREA PUBLIC SCHOOL RENOVATION TO R.R. OEHRLI ELEMENTARY 4859 KNUDSEN ST. MONTAGUE, MI

SEAL & SIGNATURE

DATE: ISSUED FOR:

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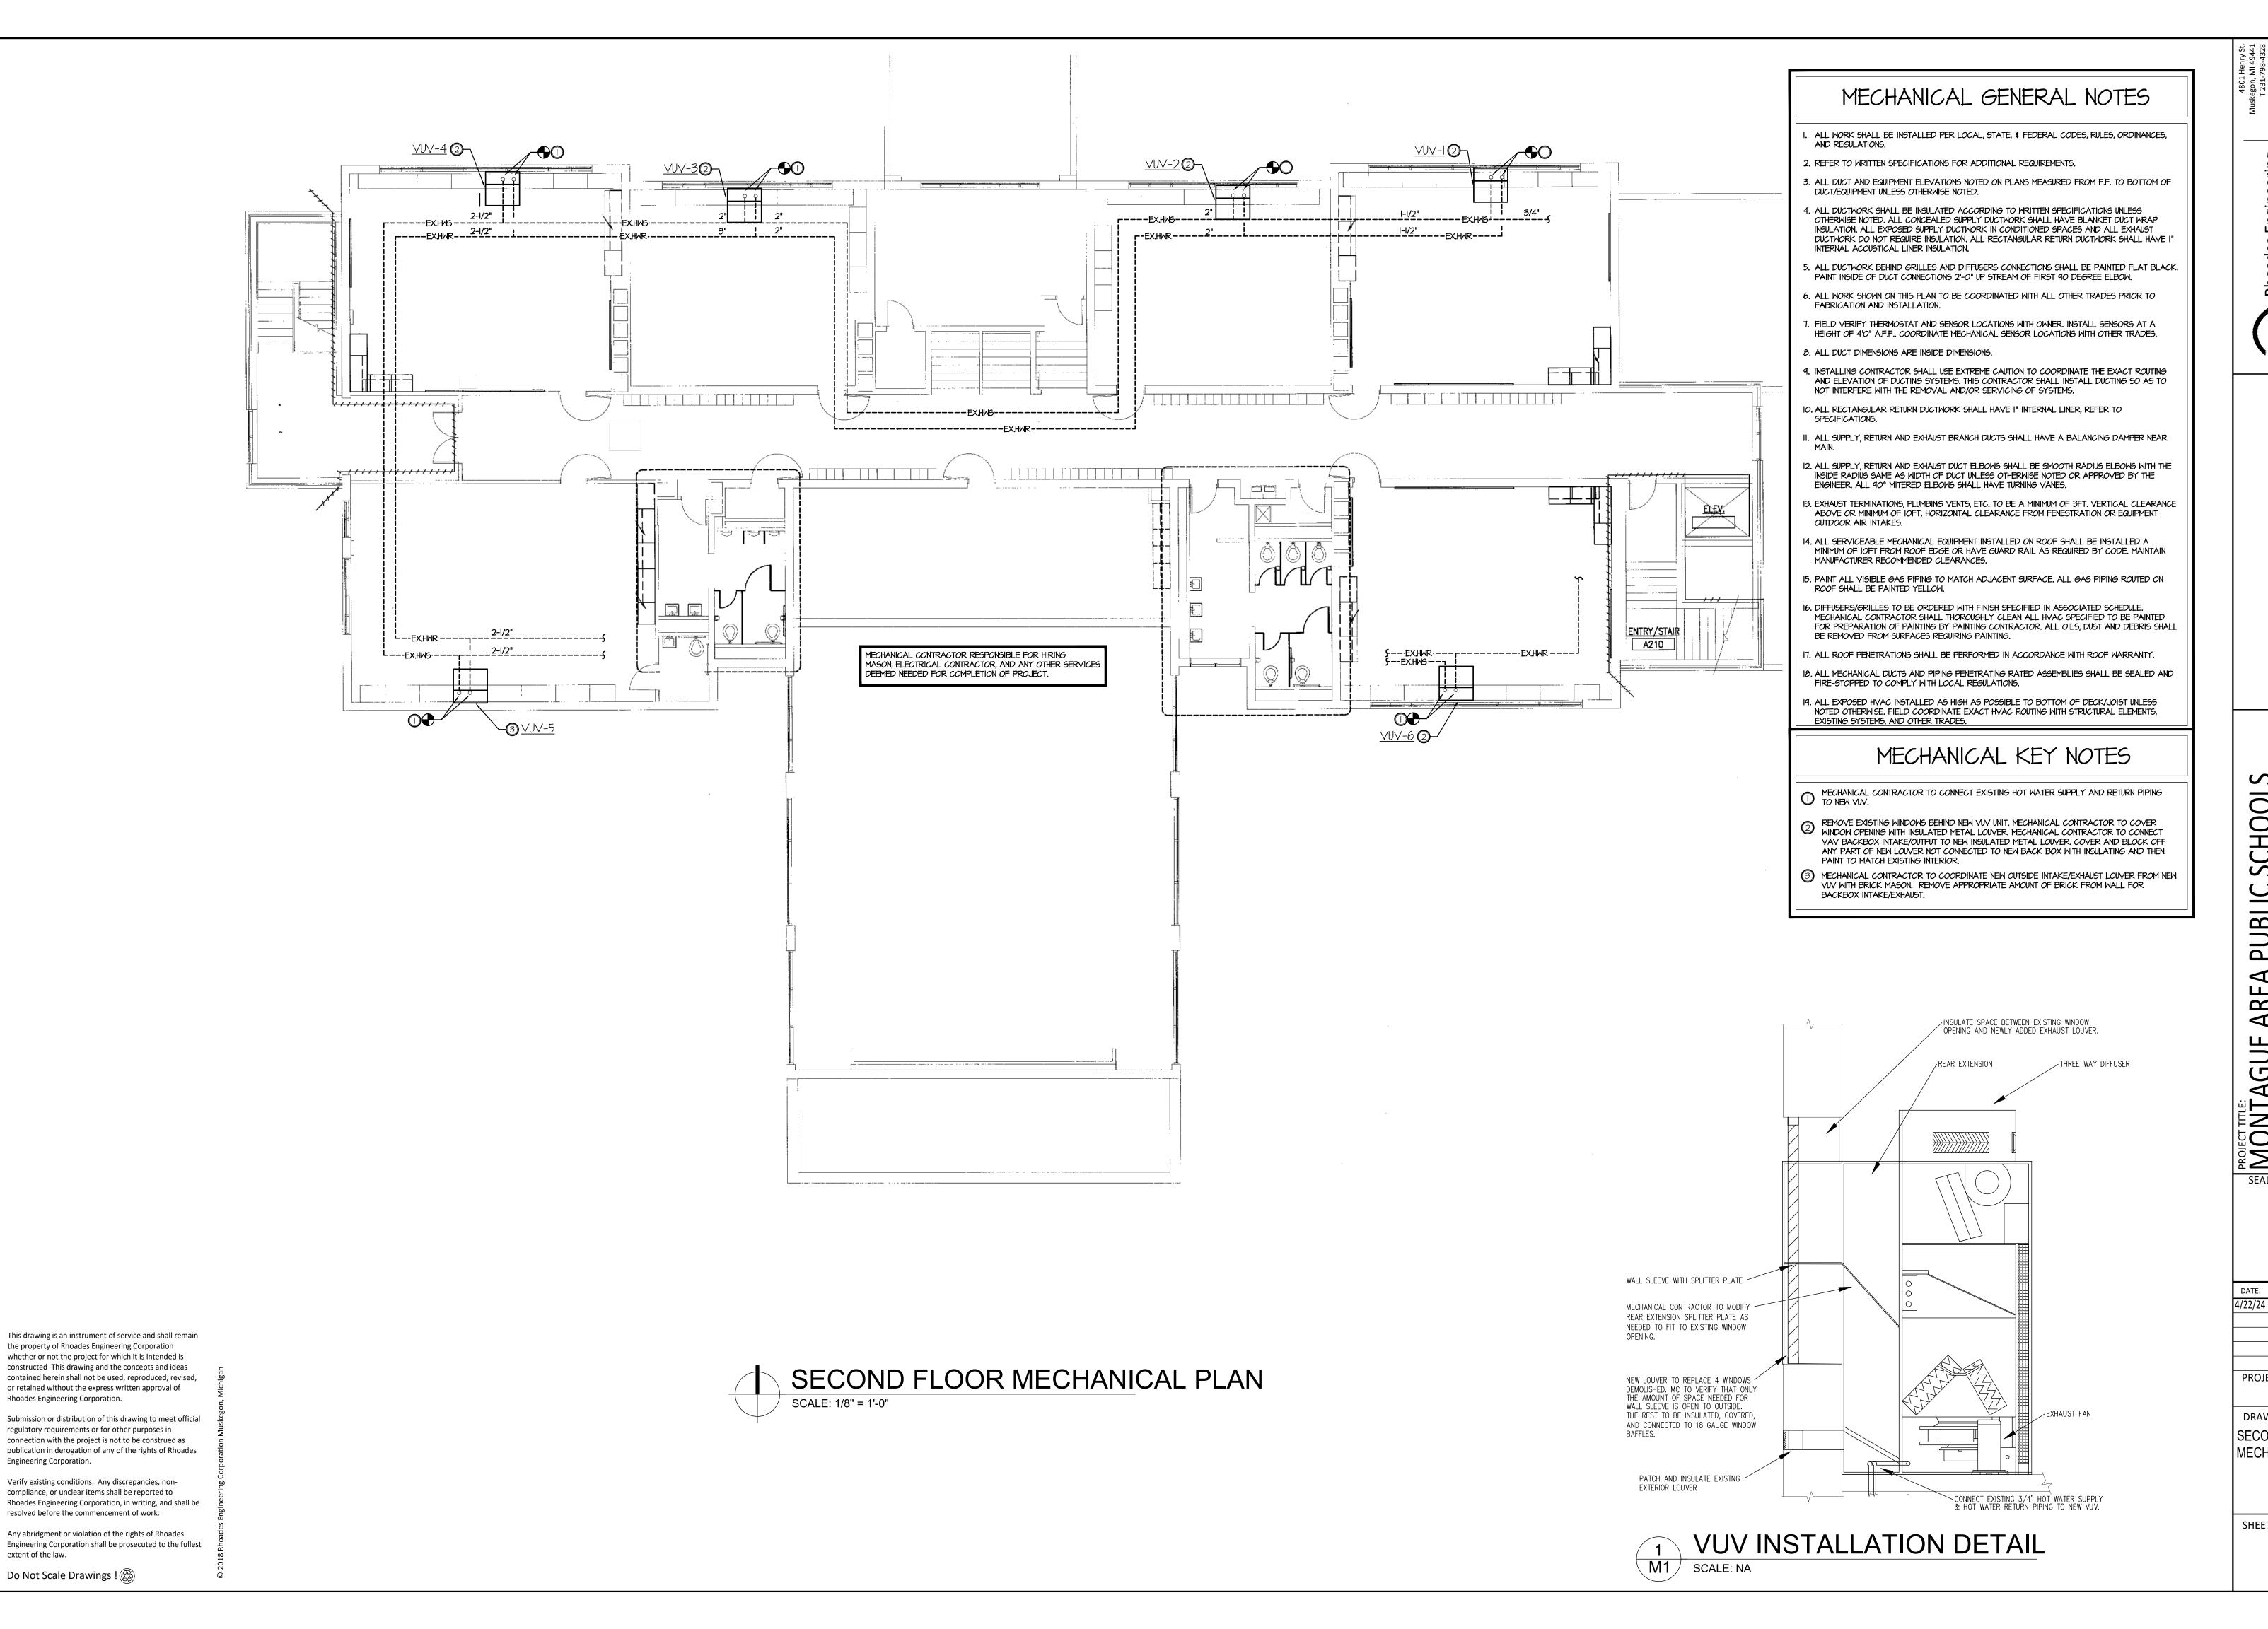
4/22/24 PERMITS, BIDS & CONSTRUCTION

PROJECT No. 5143

DRAWING TITLE:
SECOND FLOOR
MECHANICAL
DEMOLITION PLAN

SHEET No.

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Rhoades Engineering Corporation.

Engineering Corporation.

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SEAL & SIGNATURE

ISSUED FOR: 4/22/24 PERMITS, BIDS & CONSTRUCTIO

PROJECT No. 5143

DRAWING TITLE: SECOND FLOOR MECHANICAL PLAN

SHEET No.

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4/22/24 PERMITS, BIDS 8

5143

**DRAWING TITLE:** 

MECHANICAL

DETAILS AND

SCHEDULES

SHEET No.

PROJECT No.

ISSUED FOR:

CONSTRUCTION

DATE:

UNIT VENTILATOR SCHEDULE SYMBOL | CFM | E.S.P. | % O.A. | E.A.T. | L.A.T. | MBH | E.W.T. | L.W.T. | GPM | V/0 | NOTE | REMARKS EQUAL TO AIREDALE MODEL #CMD36BCMACANNN92NI 24% | 80/67 | 60.7/57.9 | 24.2 | 50 NA | 6 GPM | 208-60-1| 1,2 24% | 80/67 | 60.7/57.9 | 24.2 | 50 NA | 6 GPM | 208-60-1 | 1,2 EQUAL TO AIREDALE MODEL #CMD36BCMACANNN92NI VV-3 | 1100 | 24% 80/67 60.7/57.9 24.2 50 NA 6 GPM 208-60-1 1,2 EQUAL TO AIREDALE MODEL #CMD36BCMACANNN92NI 0.5 VV-4 | 1500 | 24% 80/67 59.6/57.5 33.9 50 EQUAL TO AIREDALE MODEL #CMD48BCMACANNN92NI NA | 6 GPM | 208-60-1 | 1,2 NA 6 GPM 208-60-1 1,2 EQUAL TO AIREDALE MODEL #CMD48BCMACANNN92NI VVV-6 | 1500 | 0.5 | 24% | 80/67 | 59.6/57.5 | 33.9 | 50 | NA 6 6PM 208-60-1 1,2 EQUAL TO AIREDALE MODEL #CMD48BCMACANNN92NI

NOTES: I, PROVIDE MANUFACTURES MADE BACKBOX, MODIFY AS NEEDED TO FIT TO SPACE.

2. PROVIDE MANUFACTURER MADE 3 WAY TOP MOUNTED DIFFUSER.

3. PROVIDE MANUFACTURER SHUT OFF SWITCH.

HVAC PIPING		
MPS	HIGH PRESSURE STEAM  MEDIUM PRESSURE STEAM  LOW PRESSURE STEAM  HIGH PRESSURE CONDENSATE	
——————————————————————————————————————	MEDIUM PRESSURE CONDENSATE PUMPED CONDENSATE	
	REFRIGERANT DISCHARGE	
——R5—— ——c——	REFRIGERANT SUCTION  CONDENSER WATER SUPPLY  CONDENSER WATER RETURN	
CMS	CHILLED WATER RETURN	
HWR	HOT WATER SUPPLY  HOT WATER RETURN  HEAT PUMP WATER SUPPLY	
HPWR	HEAT PUMP WATER RETURN	

			BASIC PLUM	IBING PIPING			
——————————————————————————————————————	FUEL OIL DISCHARGE FUEL OIL GAGE FUEL OIL SUCTION FUEL OIL RETURN FUEL OIL TANK VENT		AIR LINE VALVE BACK FLOW PREVENTOR BALANCING VALVE BALL VALVE		EXPANSION JOINT  EXPANSION LOOP  FLOW ARROW	P.5. '••••••••••••••••••••••••••••••••••••	PRESSURE SWITCH PUMP REDUCER, CONCENTRIC SILL COCK
——————————————————————————————————————	COMPRESSED AIR VACWM (AIR) SAN DRAIN ABOVE FLOOR		BUTTERFLY VALVE  CHECK VALVE  CIRCUIT SETTER  GAS COCK	——   —— PF.s	FLOWMETER, ORIFICE FLOWSWITCH		STRAINER STRAINER, BLOW OFF
——————————————————————————————————————	GAN DRAIN BELOW FLOOR  STORM DRAIN ABOVE FLOOR  STORM DRAIN BELOW FLOOR  EMERGENCY STORM DRAINAGE		GATE VALVE GLOBE VALVE PRESSURE REDUCING VALVE	[—  —	PIPING CAP WALL CLEAN OUT (MCO) PIPING CONTINUATION	—————————————————————————————————————	THERMOMETER THERMOMETER WELL TRAP, STEAM
ESD E	EMERGENCY STORM BELOW FLOOR VENT COLD WATER		RELIEF VALVE  RISE AND DROP VALVE	<del></del> ≎ ₽	PIPE DROP, BOTTOM  PIPE DROP	<del></del>	UNION NEW UPRIGHT SPRINKLER HEAD
—————————————————————————————————————	HOT WATER HOT WATER RECIRC. SAS	——————————————————————————————————————	SOLENOID VALVE THREE WAY VALVE	<b>──</b>	PIPE RISE	——⊙——————————————————————————————————	EXIST. UPRIGHT SPRINKLER HEAD NEW PENDENT SPRINKLER HEAD
——————————————————————————————————————	acid waste Dxy <i>g</i> en	——————————————————————————————————————	TWO WAY VALVE ALIGNMENT GUIDE	<u>+ → R</u> + Ω	PITCH OF PIPE, RISE (R) DROP (D)		EXIST. PENDENT SPRINKLER HEAD FLOOR DRAIN (SEE SPECS)
NONI	IITROGEN IITROUS OXIDE FIRE PROTECTION	<del></del>	ANCHOR, INTERMEDIATE	T	PRESSURE GAUGE AND COCK	<b>D</b> (©)	FLOOR SINK (SEE SPECS) FLOOR CLEAN OUT ROOF DRAIN

ARCHITECTURAL AND STRUCTURAL PLANS FOR CLEARANCES.		
ALL PIPING SHALL BE INSTALLED TO FACILITATE COIL REMOVAL, FILTER REPLACEMENT		
AND OPENING OF ACCESS PANELS.		
INSTALL MAINS AS HIGH AS POSSIBLE, MANUAL AIR VENTS SHALL BE PROVIDED AT ALL		
PIPING HIGH POINTS AND END OF PIPING LOOPS. PROVIDE REMOVABLE INSULATION		
PLUG.		_
PIPE ANCHORS, EXPANSION LOOPS, AND GUIDES SHALL BE PROVIDED AS REQUIRED.		
REFER TO SPECIFICATIONS.		
SLEEVE AND SEAL EXTERIOR WALL AND ROOF PENETRATIONS TO A WEATHER TIGHT		
CONDITION.		
PROVIDE MINIMUM OF 3/4" PIPE FOR ALL PIPING UNLESS SHOWN OTHERWISE.		
ALL VALVES ARE TO BE FULL LINE SIZE EXCEPT CONTROL AND BALANCING VALVES.		
PROVIDE 1/2" DRAIN VALVES WITH HOSE-END CAPS AT ALL LOW POINTS IN PIPING.		
PROVIDE MINIMUM PITCH SUFFICIENT TO INSURE ADEQUATE DRAINING, PROVIDE		
REMOVABLE INSULATION PLUG.		
UNLESS OTHERWISE NOTED, ALL PIPING IS OVERHEAD AND AS HIGH AS POSSIBLE TO		
THE UNDERSIDE OF THE STRUCTURE OR SLAB, WITH SPACE FOR INSULATION WHERE		
REQUIRED.		
PIPING AND ASSOCIATED APPURTENANCES SHALL NOT INTERFERE WITH DOORS AND		
MINDOMS.		
ALL PIPING WORK SHALL BE COORDINATED WITH ALL TRADES INVOLVED, PROVIDE		
OFFSETS IN PIPING AROUND OBSTRUCTIONS ENCOUNTERED IN FIELD.		
PROVIDE VIBRATION ISOLATORS FOR ALL PIPING SUPPORTS CONNECTED TO, AND		
WITHIN 50 FEET OF ISOLATED EQUIPMENT (EXCEPT AT BASE ELBOW SUPPORTS AND		
ANCHOR POINTS) THROUGHOUT MECHANICAL EQUIPMENT ROOMS.		
FOR BALANCING 3-WAY VALVES, BALANCE BY-PASS WITH VALVE AT 50% POSITION SUCH		
THAT TOTAL FLOW DOES NOT EXCEED 100%.		
CONDENSATE WATER PIPING SHALL BE A MINIMUM OF 3/4". SEE THE DETAILS SHOWN IN		
THE DRAWINGS OR MANUFACTURER'S LITERATURE BOILER CONDNSATE PIPING		
ARANGEMENT, PITCH DOWN IN DIRECTION OF FLOW, MINIMUM I INCH PER 10 FEET.		
INSTALL PIPING SO ALL VALVES, STRAINERS, UNIONS, TRAPS, FLANGES AND OTHER		
APPURTENANCES REQUIRING ACCESS ARE ACCESSIBLE.		
PROVIDE PRESSURE/TEMPERATURE (P/T) PLUGS, WITH CAPS UP AND DOWNSTREAM OF		
ALL EQUIPMENT, AT THE SUPPLY AND RETURN TAPS OF ALL PIPING BRANCHES AND/OR WHERE INDICATED. PROVIDE EXTENDED PLUGS AND LABELS WHERE PIPING IS		
INGULATED. PROVIDE EXTENDED PLOGS AND LABELS WHERE FIFTING IS		
PROVIDE FLUSHING VALVES AND TEES AT BOTH ENDS OF ALL EQUIPMENT. TAPS SHALL		II —
MATCH EQUIPMENT PIPING UP TO 1". FOR LARGER EQUIPMENT AND PIPE LOOPS,		
PROVIDE 1-1/2" TAPS AND VALVES.		
ALL HYDRONIC PIPING BRANCH TAKEOFFS FROM MAINS SHALL BE MADE WITH SWING		
JOINTS.		
NEW PIPING PASSING THRU EXISTING WALLS AND / OR FLOORS SHALL BE CORE DRILLED		
FOR SLEEVE.		
MECHANICAL CONTRACTOR SHALL CONFIRM THAT ALL EXISTING VALVES WITHIN THE		II
SERVICE OF WORK ARE OPERATIONAL AT TIME OF INSPECTION IF VALVE FAILS PROVIDE		
A PRICE FOR REPAIRS OR REPLACEMENT OF THE VALVE.		
MECHANICAL CONTRACTOR SHALL FLUSH AND CLEAN ALL STRAINERS IN THE VICINITY		II —
OF THEIR WORK,		II ‡
OFFSET PIPING TO ACCOMMODATE LARGE DUCTWORK, COORDINATE IN FIELD.		
PIPING PASSING THROUGH RATED FLOORS & WALLS SHALL BE SLEEVED AND FIRE		
STOPPED IN COMPLIANCE WITH THE LATEST CODE, ACCEPTABLE INSTALLATION		
METHODS, MATERIALS SHALL BE AS MANUFACTURED BY "HILTI".		· · · · · · · · · · · · · · · · · · ·
NEW PIPING PASSING THRU EXISTING WALLS AND / OR FLOORS SHALL BE CORE DRILLED		
FOR SLEEVE.		[
PROVIDE ALL MISCELLANEOUS STEEL AND ITEMS REQUIRED FOR THE PROPER		
INSTALLATION OF ALL PIPE, SHEET METAL AND EQUIPMENT.		
DO NOT INSTALL EQUIPMENT, PIPING OR DUCTWORK OVER ANY ELECTRICAL EQUIPMENT		I
OR COMMUNICATION ROOMS. DO NOT RUN ANY PIPING OR DUCTWORK INTO THE		l
ELECTRICAL ROOM UNLESS DEDICATED TO SERVE THAT ROOM.		
ALL BOILER CONDENSATE DRAIN PIPING TO TERMINATE TO DRAIN VIA AIR GAP.		
	]	
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GENERAL HYDRONICS NOTES:

ARCHITECTURAL AND STRUCTURAL PLANS FOR CLEARANCES.

THE INSTALLATION OF ALL PIPING SHALL BE CLOSELY COORDINATED WITH SHEET METAL, ELECTRICAL, AND STRUCTURAL CONDITIONS. NOT ALL REQUIRED OFFSETS AND FITTINGS ARE INDICATED ON DRAWINGS, BUT SHALL BE PROVIDED. REFER TO EXISTING

	HVAC DU	J WORK	
	SLOT DIFFUSER SUPPLY AIR DIFFUSER	14X2O	DUCT SIZE, FIRST FIGURE IS SIDE SHOWN
	RETURN AIR DIFFUSER		ACOUSTICAL LINING (INSULATION)
<u> </u>	SUPPLY AIR DUCT SECTION, FIRST FIGURE IS TOP	<u> </u>	CHANGE IN ELEVATION, RISE (R) DROP (D)
20XI4	RETURN AIR DUCT SECTION, FIRST FIGURE IS TOP		STANDARD BRANCH, NO SPLITTER
<b>(</b>	EXHAUST FAN	<b>************</b>	FLEX CONNECTION
	VERTICAL FIRE DAMPER	T	THERMOSTAT
	VERTICAL FIRE/SMOKE DAMPER	$\bigcirc$	THERMOSTAT WITH GUARD
	HORIZONTAL FIRE DAMPER	(5)	TEMPERATURE SENSOR
	HORIZONTAL FIRE/SMOKE DAMPER	$\bigoplus$	HUMIDISTAT
	SMOKE DAMPER	<b>\langle</b>	DEMOLITION NOTES TAG
V.D.	MANUAL VOLUME DAMPER	<b>⊗</b>	REVISED NOTES TAG  ADDENDUM TAG
5	MANUAL SPLITTER	$\langle xx \rangle$	EQUIPMENT NOTES TAG

AFF	ABOVE FINISHED FLOOR	EC	ELECTRICAL CONTRACTOR	M.C.	MECHANICAL CONTRACTOR
AHU	AIR HANDLING UNIT	EF	EXHAUST FAN	OA	OUTSIDE AIR
ASME	AMERICAN SOCIETY OF	EMC	ELECTRIC WATER COOLER	RA	RETURN AIR
	MECHANICAL ENGINEERS	EMT	ENTERING WATER TEMPERATURE	SA	SUPPLY AIR
BF	BARRIER FREE	EXIST.	EXISTING	SAN	SANITARY SEWER
BTUH	BRITISH THERMAL UNITS PER HOUR	FCO	FLOOR CLEAN OUT	<b>5</b> C	SITE CONTRACTOR
CA	COMBUSTION AIR	FD	FLOOR DRAIN	SP	STATIC PRESSURE
CFM	CUBIC FEET PER MINUTE	FT	FIN-TUBE RADIATION	55	SERVICE SINK
co	CLEAN OUT	<i>G</i> PM	GALLONS PER MINUTE	ST	STORM SEWER
COND	CONDENSATE	HP	HORSE POWER	UH	UNIT HEATER
CSBV	CIRCUIT SETTER	HWR	HOT WATER RETURN	UR	URINAL
CODY	BALANCING VALVE	HWS	HOT WATER SUPPLY	٧	VENT
CU	CONDENSING UNIT	I.E.	INVERT ELEVATION	VTR	VENT THRU ROOF
CUH	CABINET UNIT HEATER	LAT	LEAVING AIR TEMPERATURE	MC	WATER CLOSET
C.M.	COLD WATER			MCO	WALL CLEAN OUT
EAT	ENTERING AIR TEMPERATURE	LAV	LAVAT <i>O</i> RY	MH	WATER HEATER
		LWT	LEAVING WATER TEMPERATURE	WS	WORK SINK

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